

Application for URBAN DESIGN COMMITTEE Review

Department of Planning and Development Review Planning & Preservation Division 900 E. Broad Street, Room 510 Richmond, Virginia 23219 (804) 646-6335

http://www.richmondgov.com/CommitteeUrbanDesign

Application Type Addition/Alteration to Existing Structure New Construction Streetscape Site Amenity	Encroachment Master Plan Sign Other	Review Type Conceptual Final
Project Name:		
Project Address:		
Applicant Information (on all applications other than encroachments, a City agence)	·	
Name:	Email:	
City Agency:	Phone: _	
Address:		
Main Contact (if different from Applicant):		
Company:	Phone: _	
Email:		

Submittal Deadlines

All applications and support materials must be filed no later than 21 days prior to the scheduled meeting of the Urban Design Committee (UDC). Please see the schedule on page 3 as actual deadlines are adjusted due to City holidays. Late or incomplete submissions will be deferred to the next meeting.

Filing

Applications can be mailed or delivered to the attention of "Urban Design Committee" at the address listed at the top of this page. It is important that the applicant discuss the proposal with appropriate City agencies, Zoning Administration staff, and area civic associations and residents prior to filing the application with the UDC.

UDC Background

The UDC is a ten member committee created by City Council in 1968 whose purpose is to advise the City Planning Commission on the design of projects on City property or right-of-way. The UDC provides advice of an aesthetic nature in connection with the performance of the duties of the Commission under Sections 17.05, 17.06 and 17.07 of the City Charter. The UDC also advises the Department of Public Works in regards to private encroachments in the public right-of-way.

IDLEWOOD AVENUE MODERN ROUNDBAOUT PROJECT

Project Narrative

The intersection of Idlewood Avenue, Grayland Avenue, and the Downtown Expressway off-ramp (VA-195) is identified for reconstruction as a modern roundabout. Along with the proposed roundabout, Idlewood Avenue is to be converted from one-way to two-way travel between S. Harrison Street and S. Cherry Street. A byproduct of these improvements is a partial removal of Grayland Avenue between S. Harrison Street and the Downtown Expressway off-ramp. This project increases traffic efficiency within the Randolph and Oregon Hill areas by allowing two-way travel between S. Harrison Street and S. Cherry Street along Idlewood Avenue. Furthermore, roadway network connectivity is increased by the addition of a right-turn movement from the Downtown Expressway off-ramp to Idlewood Avenue west bound which provides a shorter travel distance to S. Harrison Street in comparison to existing conditions. This project will also improve safety and reduce travel speeds. The project is designed to enable pedestrians to safely walk along from S. Cherry Street to S. Harrison Street by connecting existing sidewalks and adding cross walks where feasible.

The current engineer's opinion of probable construction cost is \$600,000. The project is funded by multiple sources. Virginia Commonwealth University will provide \$250,000, FY2014 Revenue Sharing – a 50-50 split between the Commonwealth of Virginia and the City of Richmond – will provide \$200,000, and finally Traffic Calming CIP2014 will provide \$200,000.

In vicinity of the study area is Virginia Commonwealth University (VCU) – Monroe Park Campus, located to the north of the Downtown Expressway and accessible via S. Harrison Street and S. Cherry Street. In addition, the VCU Cary Street Sports Field and adjacent gymnasium and tennis courts and the Altria Theater attract residents and visitors to the area. Located to the south of Idlewood Avenue are historic Hollywood Cemetery, Clark Springs Elementary School, and Open High School.

CITY OF RICHMOND, VIRGINIA

DEPARTMENT OF PUBLIC WORKS BUREAU OF ENGINEERING





VDOT UPC - 104279

VICINITY SKETCH
(NOT TO SCALE)

FUNCTIONAL CLASSIFICATION AND TRAFFIC DATA

IDLEWOOD AVENUE
URBAN MINOR COLLECTOR GS-7 - UNDIVIDED - ROLLING

Fr: INT WITH HARRISON AVENUE
To: INT WITH CHERRY STREET

ADT (2014) 7,300 VPD

DHV 657 VPH

D (X) (design hour) 61X

T (X) (design hour) 1X

V (MPH) 30 MPH (POSTED SPEED LIMIT 25 MPH)

INDEX	OF SHEETS
Sheet Number	Sheet Title
1	TITLE SHEET
1A(1)	SURVEY DATA — ALIGNMENT DATA
1A(2)	SURVEY DATA — EXISTING SURVEY DATA
1B	CONSTRUCTION ALIGNMENT DATA SHEET
10	RIGHT-OF-WAY DATA SHEET
1D	TRAFFIC MANAGEMENT PLAN
1E	VIRGINIA WORK AREA PROTECTION
2	GENERAL NOTES
2A(1)	TYPICAL SECTIONS
2A(2)	TYPICAL SECTIONS
28	DRAINAGE DESCRIPTIONS
2C	TOP OF CURB ELEVATION DETAILS
3	PLAN SHEET - IDLEWOOD AVE. STA. 104+02.96 TO STA. 108+64.24
3A	IDLEWOOD, RAMP & DRIVEWAY PROFILE
4	LANDSCAPE PLAN
5	LANDSCAPE DETAILS
XS-1	CROSS SECTIONS - IDLEWOOD AVE
XS-2	CROSS SECTIONS - IDLEWOOD AVE
XS-3	CROSS SECTIONS - RAMP

DESIGN FEATURES RELATING TO CONSTRUCTION OR TO REGULATION AND CONTROL OF TRAFFIC MAY BE SUBJECT TO CHANGE AS DEEMED NECESSARY BY THE DEPARTMENT

THIS PROJECT IS TO BE CONSTRUCTED IN ACCORDANCE WITH THE CIT OF RICHMOND DESIGN AND CONSTRUCTION STANDARDS MANUAL, 2007 VDOT ROAD AND BRIDGE SPECIFICATIONS, 2008 VDOT ROAD AND BRIDGE STANDARDS, 2009 MUTCD, 2011 VIRGINIA SUPPLEMENT TO THE MUTCD, 2011 VIRGINIA WORK AREA PROTECTION MANUAL, AND AS AMENDED BY CONTRACT PROVISIONS AND THE COMPLETE PAPER VERSION OF THE PLAN ASSEMBLY INCLUDING ALL REVISIONS.

THE ORIGINAL SIGNED/APPROVED TITLE SHEET, INCLUDING ORIGINAL SIGNATURES, IS FILED IN THE CITY OF RICHMOND DEPARTMENT OF PUBLIC WORKS OFFICE.

N. CARY ST. 55	IN ST.
DOWNTOWN EXPY 195 PARKWOOD AVE OF PARKWOOD AVE	CUMBERLAND ST.
SHEET 3	IDLEWOOD AVE. ALBEMARLE ST. 15
	S CHERRY ST.



60% PLANS - 08/14/14


THESE PLANS ARE UNFINISHED AND UNAPPROVED AND ARE NOT TO BE USED FOR ANY TYPE OF CONSTRUCTION.

Kimley » Horr

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NOTES	Existing Curb Curb & Gutler Existing Curb Curb & Gutler Existing Curb Curb Ramp	Proposed Conc. Sidewalk	Technical	Administrative	IDLEWOOD AVENUE DOUNDADOUT DOOLEOT
1. Lot dimensions in parentheses are from deed.	Sidewalk Issue State Coping Basin Saley Crossing/Driveway	Brick Sidewalk STATE OF THE CASTINGS: Water Valve OF WY	Surveys Superintendent		IDLEWOOD AVENUE ROUNDABOUT PROJECT
2. Property owners correct as of 20	Storm Sewer = 15" Fire Hydrant Sewer Manhole Bare of Payement - FP-	Castings: Valer Valve of W - Valer Neter of W - Gas Drip of C		Capital Project Administrator	
3. Ordinance Number	Sanitary Sewer (Sentity)	Gas Valve	Project Engineer		
4. Adopted	Sanitary Sewer (Name Main) 10 35 M Cornerstone Cornerstone Property Pin	- Gas Yaive - Telephone Manhole O T - Electric Manhole O F	Maintenance Engineer	Deputy Director for Transportation / Public Works	TITLE SHEET
5. Accepted	Telephone/Telegraph //g Proposed Sewer	Proposed Curb Cut Ramp	City Traffic Engineer	Director of Public Works	CIP: 040-000-000-0000
REFERENCES REVISIONS	- TV Cable CATV Nanhole Substitution CATV Nanhole Substitution CATV Nanhole Substitution Substituti	Decorative Light Conduit	DEPARTMENT OF	PUBLIC WORKS	DESIGN BY: MH REVIEWED BY FIELD NOTES SCALE DATE DRAWING NO. SHEET NO.
BL: XX NW, NE, SW, SE	Tree / Exist. Tree To Be Removed / Stump 50 / \$2 / © Curb & Gutter Property Line — — 1 — Asphalt	Conduit (Conc. Encased)	RICHMOND,		DESIGN BY: MH REVIEWED BY PIELD NOTES SCALE DATE DRAWING NO. SHEET NO. DRAWN BY: RSP CHRCKED BY: BAM AS NOTED 08-14-14 X-XXXXX 1

SURVEY ALIGNMENT DATA

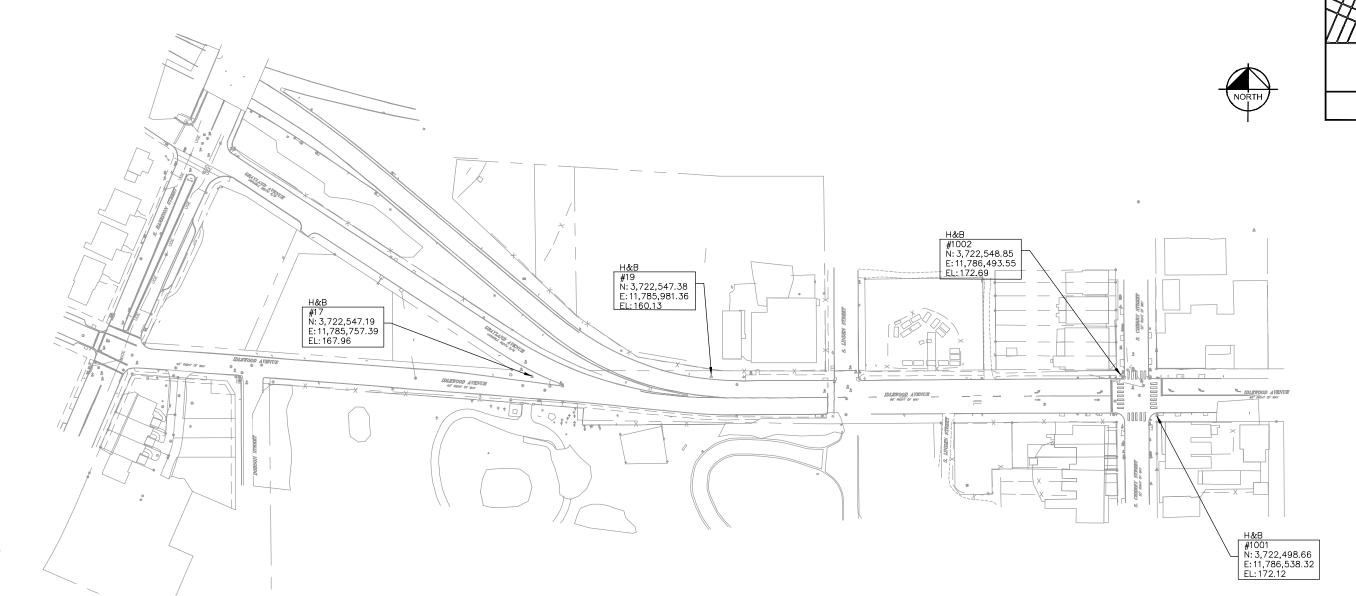

NOTES:

1. INLET INVERTS SHOWN HEREON ARE APPROXIMATE AND SHOULD BE VERIFIED PRIOR TO CONSTRUCTION OR DESIGN TIE IN.

2. EXISTING GROUND SURFACE LOCATION PERFORMED BY CONVENTIONAL INSTRUMENT SURVEY.

3. HORIZONTAL (NAD'83) AND VERTICAL (NAVD'88) DATUM ESTABLISHED THROUGH REAL TIME KINEMATIC (RTK) GPS OBSERVATIONS ON JUNE 05, 2013. DIFFERENTIAL CORRECTIONS WERE DERIVED FROM NATIONAL GEODETIC SURVEY (NGS) CONTINUALLY OPERATING REFERENCE STATION (CORS) "LOYS". COORDINATE VALUES, IF SHOWN HEREON, ARE BASED ON VIRGINIA STATE GRID, SOUTH ZONE.

4. UNDERGROUND UTILITIES WERE DESIGNATED (PAINTED) BY MISS UTILITY OF VIRGINIA. H & B SURVEYING AND MAPPING, LLC SURVEYED THE PAINTED LINE AS PAINTED AND IS NOT RESPONSIBLE FOR THE ACCURACY OF THE PAINT DESIGNATION. UTILITY INFORMATION ON THIS DRAWING WILL NEED TO BE FIELD VERIFIED PRIOR TO CONSTRUCTION.

5. PROPERTY LINES SHOWN HEREON TAKEN FROM COURT HOUSE RECORDS AND EVIDENCE OF MONUMENTATION AND OCCUPATION FOUND IN THE FIELD. THIS SURVEY DOES NOT CONSTITUTE A BOUNDARY SURVEY AND WAS PREPARED WITHOUT THE BENEFIT OF A TITLE COMMITMENT, NO EASEMENTS ARE SHOWN ON THIS SURVEY.

THIS TOPOGRAPHIC SURVEY WAS COMPLETED UNDER THE DIRECT AND RESPONSIBLE CHARGE OF, LESLIE R. BYRNSIDE FROM AN ACTUAL GROUND SURVEY MADE UNDER MY SUPERVISION: THAT THE IMAGERY AND/OR ORIGINAL DATA WAS OBTAINED ON JUNE 05, 2013 THROUGH JUNE 25, 2013 AND THAT THIS PLAT, MAP, OR DIGITAL GEOSPATIAL DATA INCLUDING METADATA MEETS MINIMUM ACCURACY STANDARDS UNLESS OTHERWISE NOTED.

Proposed Conc. Sidewalk

REVISED 08/29/13: LABEL EXISTING CONTROL


60% PLANS - Ø8/14/14

VICINITY SKETCH (NOT TO SCALE)

THESE PLANS ARE UNFINISHED AND UNAPPROVED AND ARE NOT TO BE USED FOR ANY TYPE OF CONSTRUCTION.

Kimley »Horn

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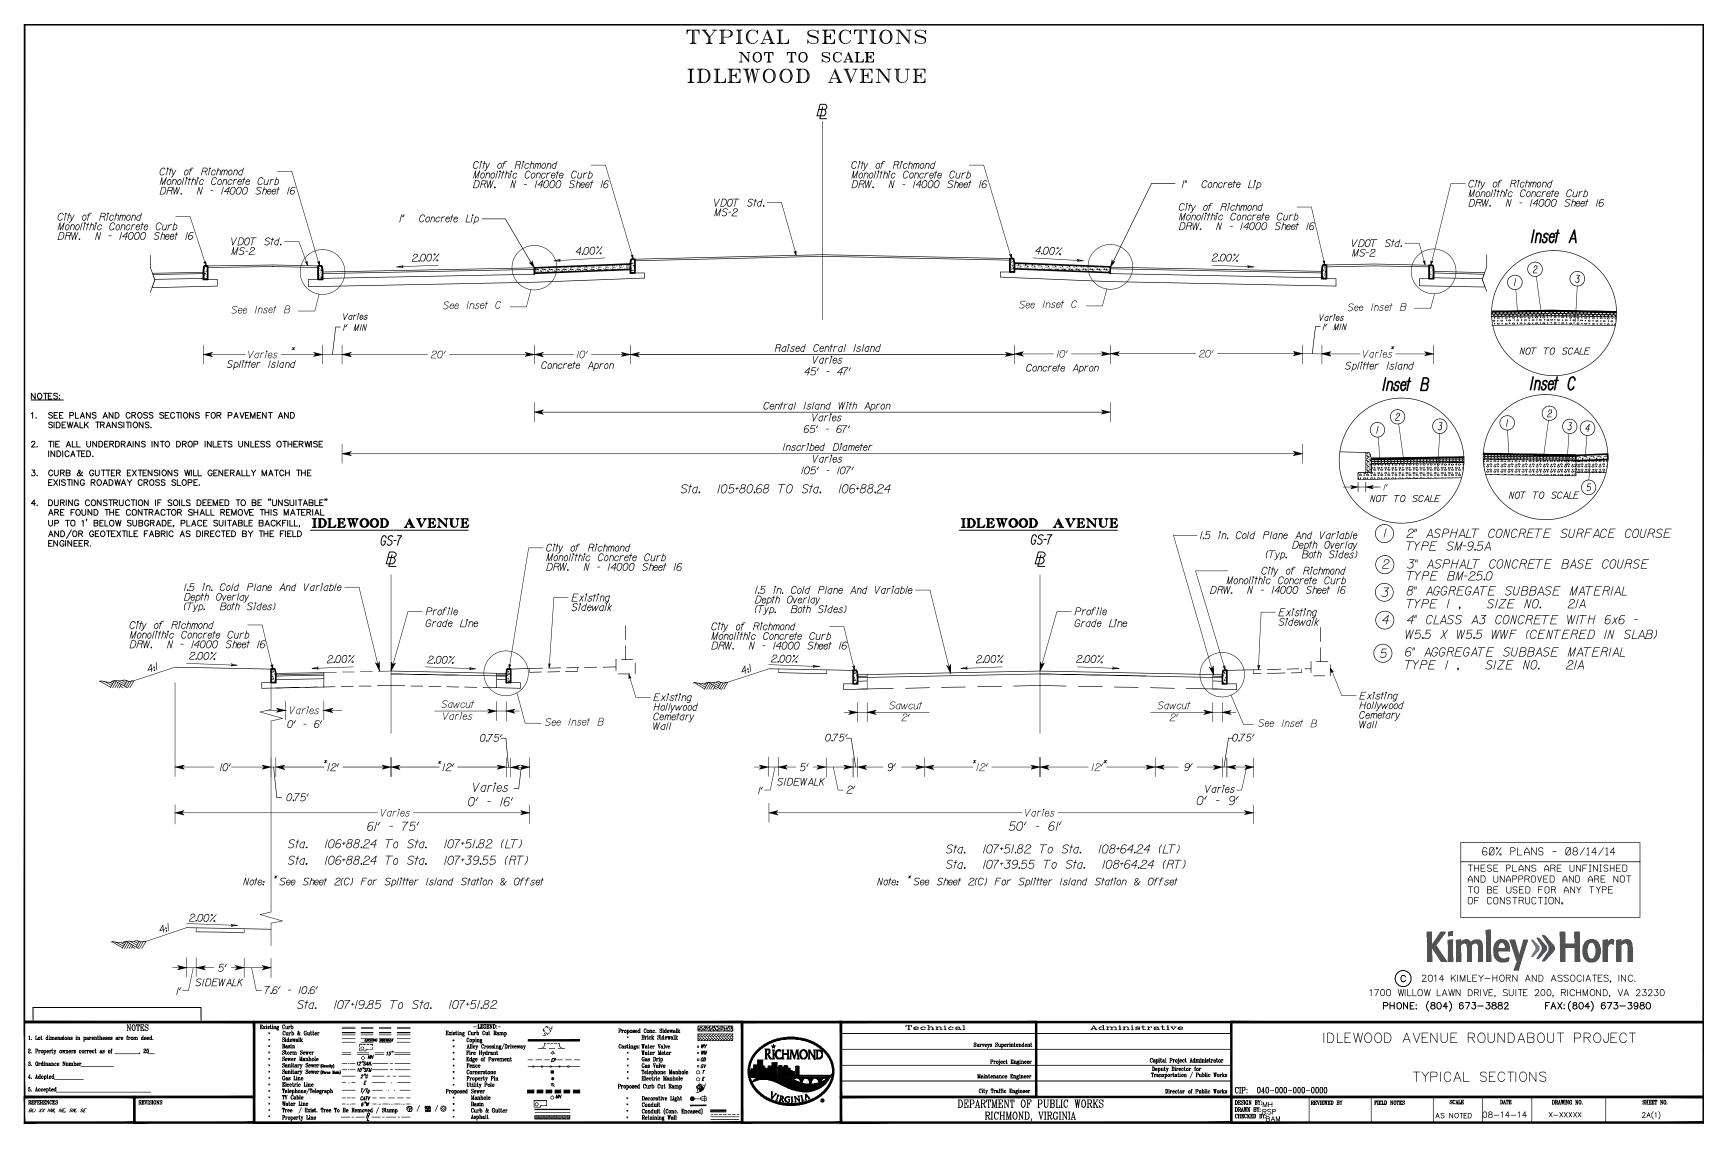


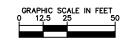
Administrative


					,			VA 23230)
PHON	NE: (8	104) 6	73–388	32	FA	X: (804)	6/3	-3980	

NOTES	Curb & Gutter Existing Curb Cut Ramp	Proposed Conc. Sidewalk	Technical	Administrative			D 01 11 1D 1 D 01 1 T	DD 0 15 0 T	
1. Lot dimensions in parentheses are from deed.	Sidewalk Zame - Coping - Coping - Alley Crossing/Driveway	Brick Sidewalk Castings: Valer Valve Valer Moter Valer Meter WW RICHMOND	Surveys Superintendent		IDL	EWOOD AVENUE	KOUNDABOUT	PROJECT	
2. Property owners correct as of, 20 3. Ordinance Number	Storm Sewer Sewer 15" Fire Hydrant Sewer Manhole Salitary Sewer Sanitary Sewer 17" SM4 Face Fence Fence Sanitary Sewer 17" SM4 Fence Fence 18" SM5 Fence 18"	- Valer Meter of War Gas Drip of Gas Captro of Cas Yaler of Cas Valer	Project Engineer	Capital Project Administrator]				
4. Adopted	Sanitary Sewer (Narve Main)	Telephone Manhole ○ 7 Electric Manhole ○ E	Maintenance Engineer	Deputy Director for Transportation / Public Works		SURVEY DATA	- ALIGNMENT	DATA	
5. Accepted	Telephone/Telegraph ///s — Proposed Sewer	Proposed Curb Cut Ramp	City Traffic Engineer	Director of Public Works	CIP: 040-000-000-0000				
REFERENCES REVISIONS BL. XX NM, NE, SW, SE	- TV Cable C47'	Decorative Light Conduit Conduit Conduit Conc Encased) Relatining Wall	DEPARTMENT OF RICHMOND,		DESIGN BY: MH DRAWN BY: RSP CHECKED BY BAM	PIELD NOTES SCALL AS NOT	1		SHEET NO. 1A(1)


Technical



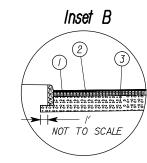

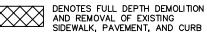

IDLEWOOD AVENUE

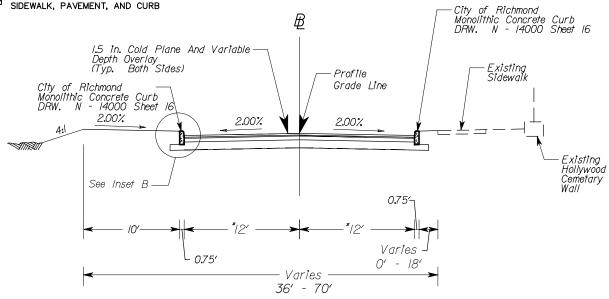

Sta. 104+02.96 To Sta. 105+80.68 Note: *See Sheet 2B(C) For Splitter Island Station & Offset

City of Richmond Monolithic Concrete Curb DRW. N - 14000 Sheet 16 — City of Richmond Monolithic Concrete Curb RW. N - 14000 Sheet 16 1.5" Cold Plane and Variable Depth Overlay (Typ. Both Sides) Profile Grade Line 0.75 SAWCUT 1' SAWCUT Overlay STA. 202+28.41 TO STA. 204+48.98

195 OFF RAMP GS-R

PRIVATE AND COMMERCIAL ENTRANCES

Crusher Run Aggr. 000000

6" Crusher Run

Aggr. 25 or 26

NOT TO SCALE

TYPE III Asphalt .

00000

time of construction.

Asphalt Conc. Type SM-9.5A @ 165 Lbs. per S. Y. 4" Aggr. Base Mat'l. Ty. I

Asphalt Commercial Asphalt Conc. Type SM-9.5A @ 165 Lbs. per S. Y. 4" Asphalt Conc. Base Course

Concrete

Concrete Entrance Pavement 7" HES 4" Aggr. Base Mat'l. Ty. I

No. 2/B

TYPE N

No. 21B BM-25.0 6" Aggr. Base Mat'l. Ty. I The type of entrance (I , II , III , IV) to be constructed will be determined by the existing condition at the


NOTES:

- SEE PLANS AND CROSS SECTIONS FOR PAVEMENT AND SIDEWALK TRANSITIONS.
- 2. TIE ALL UNDERDRAINS INTO DROP INLETS UNLESS OTHERWISE INDICATED.
- 3. CURB & GUTTER EXTENSIONS WILL GENERALLY MATCH THE EXISTING ROADWAY CROSS SLOPE. 4. DURING CONSTRUCTION IF SOILS DEEMED TO BE
- "UNSUITABLE" ARE FOUND THE CONTRACTOR SHALL REMOVE THIS MATERIAL UP TO 1' BELOW SUBGRADE, PLACE SUITABLE BACKFILL, AND/OR GEOTEXTILE FABRIC AS DIRECTED BY THE FIELD ENGINEER.
- 5. PAVEMENT CORE SAMPLES WERE DRILLED AND THE BROOKLAND PARK BLVD. MAINLINE WAS FOUND TO BE 9" OF CEMENT CONCRETE WITH 3" BITUMINOUS PAVEMENT OVERLAY AND THE EXISTING SIDE ROADS TO BE 9" BITUMINOUS PAVEMENT.

ROADWAY PAVEMENT WEDGING

Proposed Roadway Grade Shall Be As Designated On Profiles And Staking Details. Buildup Of Pavement To Desired Cross Slopes Shall Be In Accordance With Pavement Wedging Detail. (Cross Slopes Shall Be In Accordance With Profiles And

Detail Sheets.) Where Proposed Improvements Abut Existing Pavement, Condition Shall Be In Accordance With Subject

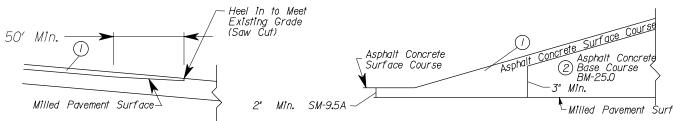


Detail For Proposed Overlay Meeting Existing Grade (Not To Scale)


Detail For Pavement Wedging (Overlay Buildup) (Not To Scale)

60% PLANS - Ø8/14/14 THESE PLANS ARE UNFINISHED AND UNAPPROVED AND ARE NOT TO BE USED FOR ANY TYPE OF CONSTRUCTION.

(C) 2014 KIMLEY-HORN AND ASSOCIATES, INC. 1700 WILLOW LAWN DRIVE, SUITE 200, RICHMOND, VA 23230 PHONE: (804) 673-3882 FAX: (804) 673-3980

NOTES	Existing Curb Curb & Gutter	-:LEGEND:- Existing Curb Cut Ramp	♥ Propo	posed Conc. Sidewalk Brick Sidewalk		Technical	Administrative						.	
1. Lot dimensions in parentheses are from deed.	Sidewalk Casino Manuar Basin	Coping Alley Crossing/Driveway				Surveys Superintendent			IDLEW	VOOD AV	ENUE RO	OND AR	OUT PRO	JECT
Property owners correct as of, 20_ Ordinance Number	Storm Sewer		<i>B</i>	ings: Water Valve owv Water Meter oww Gas Drip ogb	RÎCHMOND	Project Engineer	Capital Project Administrator							
4. Adopted	Sanitary Sewer (Parco Main) 10"SFM Cas Line 2"6	 Cornerstone Property Pin 		Gas Valve • GV Telephone Manhole • F Electric Manhole • F		Maintenance Engineer	Deputy Director for Transportation / Public Works			T	YPICAL S	ECTION	S	
5. Accepted		Utility Pole Proposed Sewer Wanhole * Wanhole	Propo	osed Curb Cut Ramp		City Traffic Engineer	Director of Public Works	CIP: 040-000-00	00-0000				_	
REFERENCES GL: XX NM, NE, SM, SE REVISIONS	- TV Cable CATV	A		Decorative Light Conduit Conduit (Conc. Encased) Retaining Wall	RGINIA	DEPARTMENT OF RICHMOND,		DESIGN BY:MH DRAWN BY:RSP CHECKED BY:BAM	REVIEWED BY	FIELD NOTES	SCALE AS NOTED O	DATE 08-14-14	DRAWING NO.	SHEET NO. 2A(2)
	rroperty tane 1	aspinati		retaining wan		itioninono,	THUMINIA	AUTO-TIES BAW			710 110125			\(-/

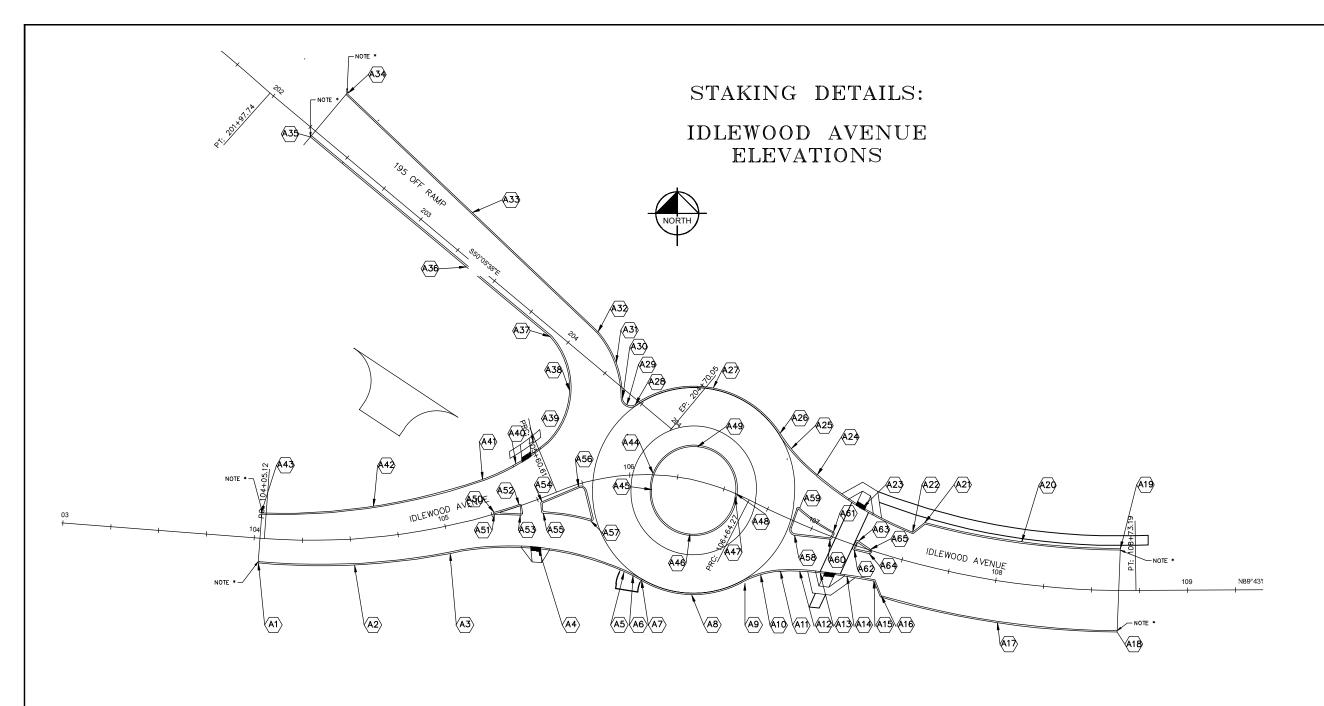

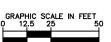

A 50	105+26.40 IDL	EWOOD	0.768	167.76
A 51	105+26.28 IDL	EWOOD	0.061	167.768
A 52	105+40.11 IDL	EWOOD	0.632	167.64
A 53	105+36.00 IDL	EWOOD	4.77	167.565
A 54	105+51.79 IDL	EWOOD	1.94	167.62
A 55	105+50.40 IDL	EWOOD	7.79	167.51
A 56	105+72.51 IDL	EWOOD	1.17	165.23
A 57	105+73.75 IDL	EWOOD	20.1	158.46
A 58	106+93.25 IDL	EWOOD	6.623	161.35
A 59	106+90.14 IDL	EWOOD	7.46	160.1
A 60	107+11.03 IDL	EWOOD	1.66	165.328
A 61	107+11.37 IDL	EWOOD	2.55	165.29
A 62	107+24.79 IDL	EWOOD	2.57	164.651
A 63	107+25.32 IDL	EWOOD	2.54	164.63
A 64	107+32.73 IDL	EWOOD	1.86	164.308
A 65	107+32.64 IDL	EWOOD	0.412	164.348

POINT	STATION	BASELINE	FACE OF CURB	ELEVATION
A 1	104+05.12	IDLEWOOD	13	170.54
A 2	104+51.37	IDLEWOOD	13.53	169.86
A 3	104+99.54	IDLEWOOD	14.3	168.42
A 4	105+42.17	IDLEWOOD	24.33	167.66
A 5	105+89.78	IDLEWOOD	47.74	166.98
A 6	105+97.27	IDLEWOOD	52.45	166.707
A 8	106+04.68	IDLEWOOD	55.09	166.59
A 9	106+79.24	IDLEWOOD	40.13	164.79
A 10	106+85.73	IDLEWOOD	32.63	165.41
A 11	106+93.84	IDLEWOOD	26.79	165.82
A 12		IDLEWOOD	22.84	165.74
A 13	107+12.32	IDLEWOOD	19.88	165.39
A 14	107+25.65	IDLEWOOD	16.76	164.81
A 15	107+39.23	IDLEWOOD	14.78	164.24
A 16	107+44.51	IDLEWOOD	21.75	163.88
A 17	108+04.03	IDLEWOOD	21.73	162.31
A 18	108+63.56	IDLEWOOD	21.696	160.22
A 19	108+64.98	IDLEWOOD	21.75	160
A 20	108+10.73	IDLEWOOD	21.76	161.76
A 21	107+56.46	IDLEWOOD	21.76	163.466
A 22	107+51.46	IDLEWOOD	15.36	163.73
A 23	107+21.55	IDLEWOOD	19.79	164.89
A 24		IDLEWOOD	26.95	166.16
A 25	106+72.30	IDLEWOOD	33.67	167.1
A 26	_	IDLEWOOD	38.23	167.69
A 27	106+33.29	IDLEWOOD	48.99	167.13
A 28	106+04.04	IDLEWOOD	36.64	166.58
A 29	106+00.67	IDLEWOOD	36.54	166.46
A 30	_	IDLEWOOD	40.27	166.41
A 31	204+25.93		8.022	165.43
A 32	204+08.43		14.3	165.7
A 33	203+25.00		19.55	161.21
A 34	202+28.65		25.62	156.1
A 35	202+28.41		3.88	156.922
A 36	203+34.20		3.74	160.667
A 37	203+90.77		3.67	163.73
A 38	204+16.60	i —	18.65	166.1
A 39		IDLEWOOD	25.8	167.7
A 40	_	IDLEWOOD	21.23	167.73
A 41	+	IDLEWOOD	19.06	167.87
A 42	_	IDLEWOOD	16.15	169.29
A 43	104+05.12		13.25	170.49
A 44		IDLEWOOD	7.70	169.831
A 45		IDLEWOOD	7.79	169.77
A 46		IDLEWOOD	27.8	169.09
A 47		IDLEWOOD	1.768	170.12
A 48		IDLEWOOD	17.24	170.127
A 49	106+31.98	IDLEWOOD	17.34	169.965

OFFSET TO

60% PLANS - Ø8/14/14

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Kimley » Horn

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NOTES Existing Curb — — — — — — — — — — — — — — — — — — —	Ø		5524529H23
Lot dimensions in parentheses are from deed. - Curo & cutter =		Brick Sidewalk	
Property owners correct as of	riveway		o WY • WM
Sewer Manhole • Edge of Pavemen	nt	 Gas Drip 	o 60
Ordinance Number Sanitary Sever (neutr) - 12 SAU - Fence Sanitary Sever (neutr) - 10 STU - Cornerstone		 Gas Valve Telephone Manhole 	∘ GV
Adopted Property Pin	-		⊙ <i>E</i>
Accepted • Electric Line E Utility Fole * Telephone/Telegraph - 1/16 Proposed Swer		Proposed Curb Cut Ramp	⊗
TV Čable CATV Nanhole		Decorative Light	
PERENCIS REVISIONS REVISIONS Nate: Line		• Conduit —	
t: XX NM, ME, SM, SE • Tree / Exist. Tree To Be Removed / Stump 50 / 252 / 20 • Curb & Gutter • Property Line — - — 1 — - — - — • Asphalt		 Conduit (Conc. Encase Retaining Wall 	ed) ====

ALL ELEVATIONS ARE AT THE TOP OF PROPOSED CURB, UNLESS OTHERWISE NOTED

* TAPER CURB HEIGHT TO MEET EXISTING CURB HEIGHT.

NOTES:


RICHMOND	
WARGINIA.	
AGINIE	


	ministrative	Technical
		Surveys Superintendent
	Capital Project Administrator	Project Engineer
	Deputy Director for Transportation / Public Works	Maintenance Engineer
CIP: 040-00	Director of Public Works	City Traffic Engineer
DESIGN BY:MH		DEPARTMENT OF
DRSIGN BY: _{MH} Drawn by: _{RSP} Checked by _{BAM}		RICHMOND,

IDLEWOOD AVENUE ROUNDABOUT PROJECT

TOP OF CURB ELEVATION DETAILS

B	CIP: 040-000-000	040-000-0000										
	DESIGN BY:MH	REVIEWED BY	FIELD NOTES	SCALE	DATE	DRAWING NO.	SHE					
	DRAWN BY: RSP CHECKED BY BAM			AS NOTED	08-14-14	X-XXXXX	2					

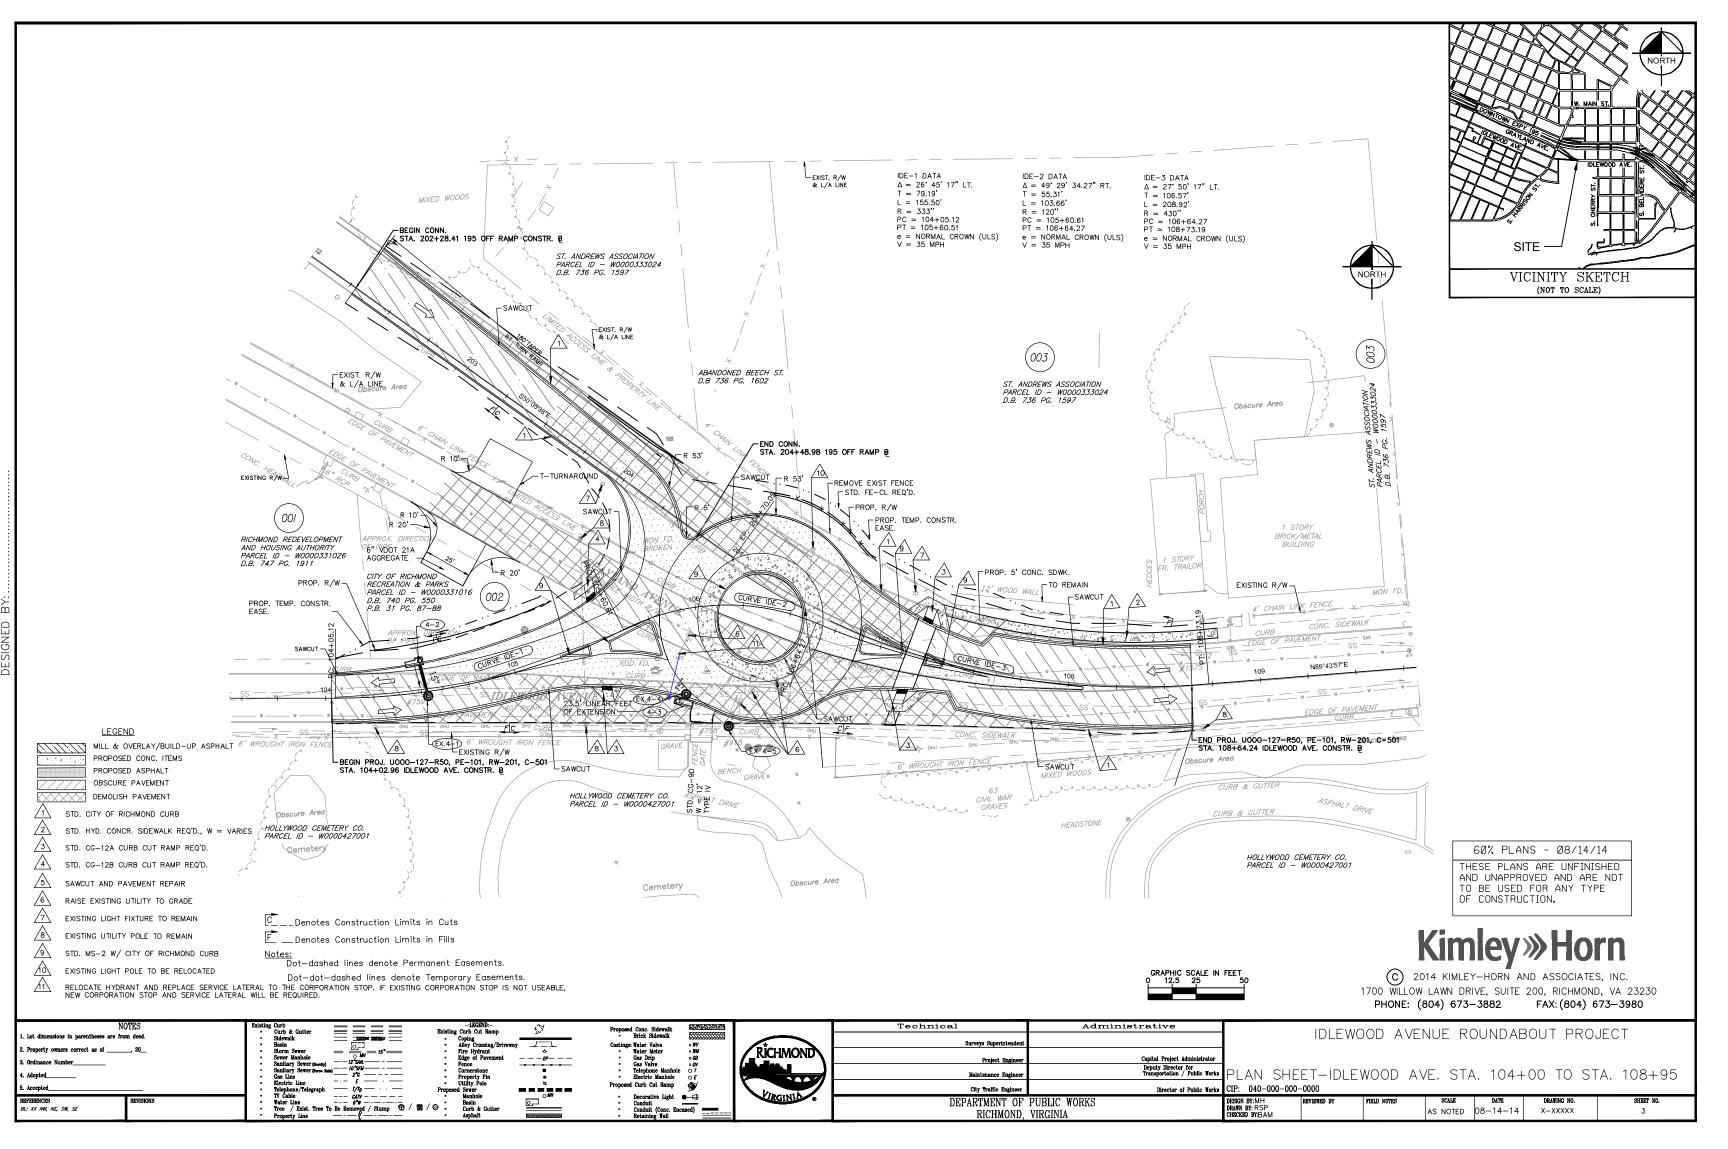

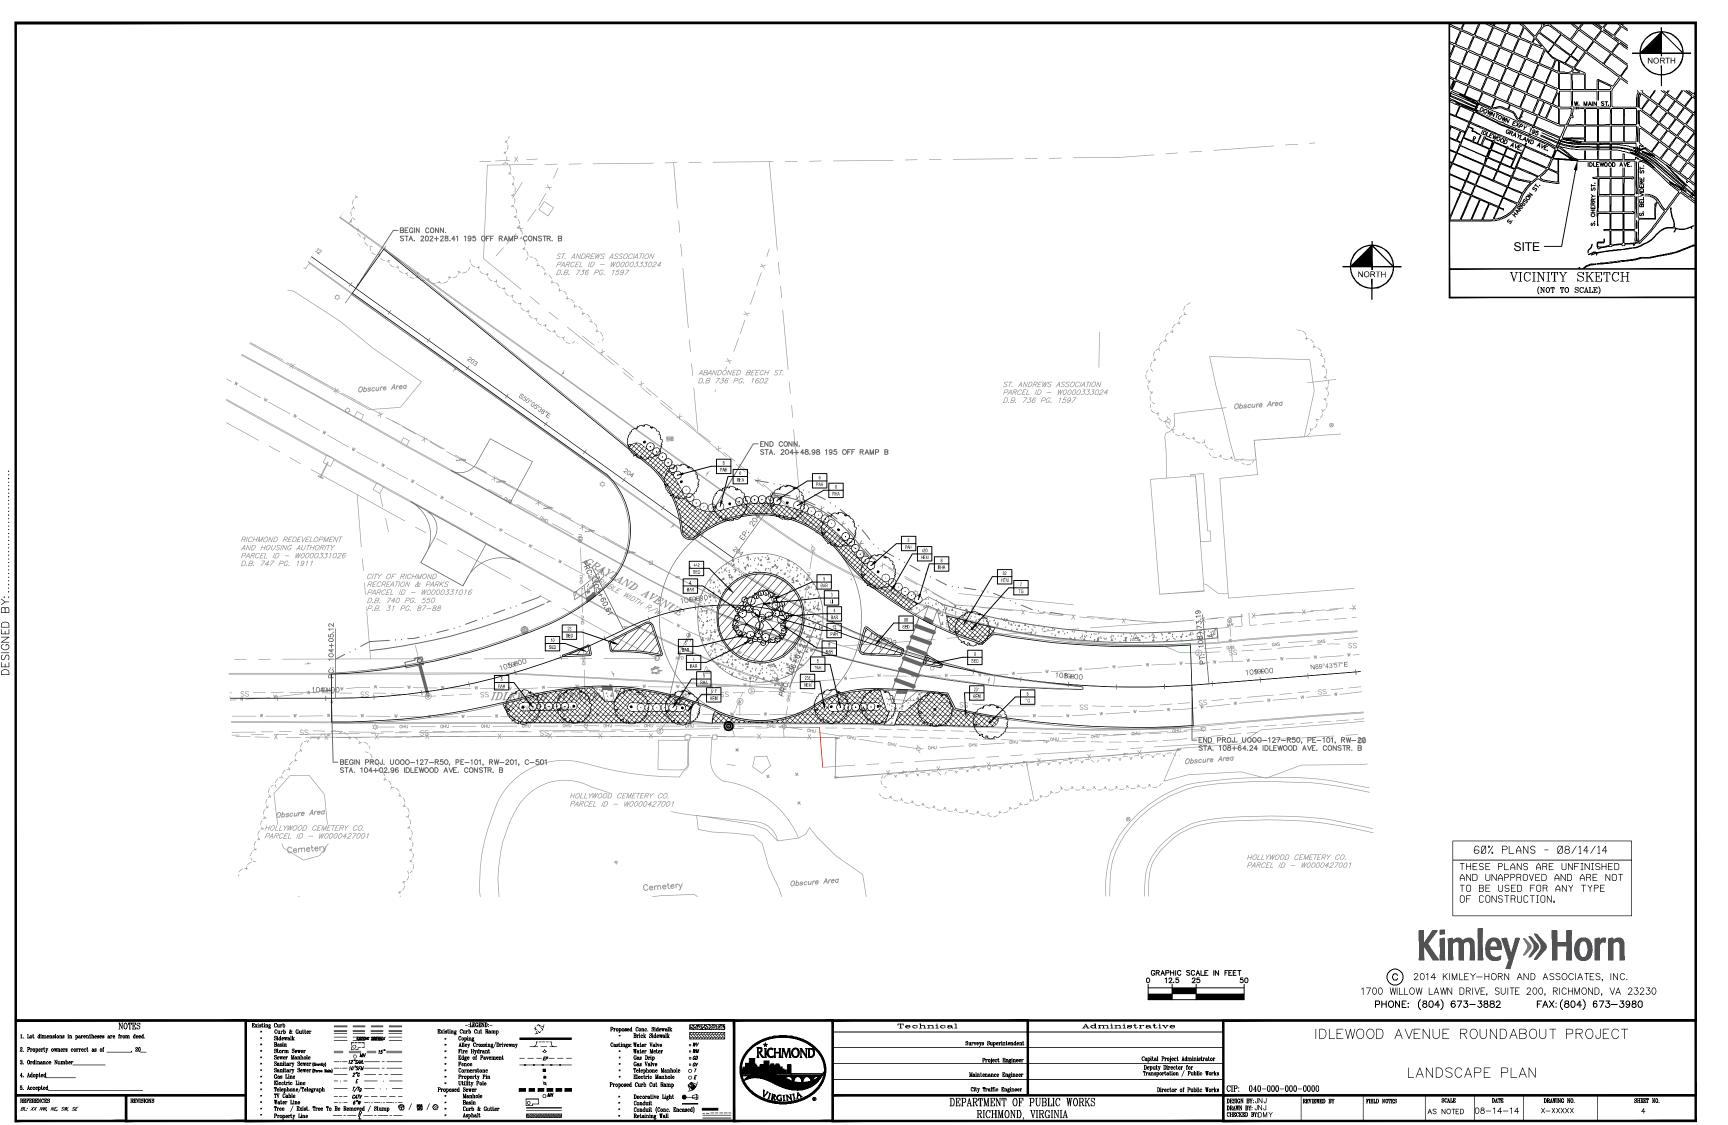

THE CONTRACTOR SHALL PROVIDE ALL LABOR, MATERIALS, ETC. NECESSARY TO COMPLETE ALL PLANTING AS SHOWN ON THE PLANTING PLANS, AS SPECIFIED HEREIN OR IN SUPPLEMENTAL SPECIFICATIONS, AND/OR AS REQUIRED BY JOB CONDITIONS. THE WORK IN GENERAL INCLUDES, BUT IS NOT LIMITED TO THE FOLLOWING:

1) SOIL PREPARATION

(2) PROVIDING TOPSOIL AND ALL SOIL AMENDMENTS:

(3) EXCAVATION OF PLANT PITS;

(4) PROVIDING ALL PLANT MATERIAL AND MULCH AS INDICATED ON

(5) FERTILIZING: (6) STAKING:

(7) CHEMICAL APPLICATION;

(8) MAINTENANCE AND GUARANTEE

(9) ALL OTHER ITEMS NECESSARY TO MAKE WORK COMPLETE THE PLANTING CONTRACTOR IS RESPONSIBLE FOR COORDINATING WORK WITH THE OTHER CONTRACTORS. THIS PLAN DOES NOT GUARANTEE THE EXISTENCE OR NON-EXISTENCE OF ANY LITH ITIES. PRIOR TO ANY CONSTRUCTION, EXCAVATION, OR ROTO-TILLING THE CONTRACTOR SHALL ASSUME THE RESPONSIBILITY OF VERIFYING THE LOCATIONS OF ALL UTILITIES, ABOVE AND/OR BELOW GROUND, PUBLIC AND/OR PRIVATE THAT MAY EXIST AND CROSS THROUGH THE AREAS OF CONSTRUCTION.

(1) SOIL PREPARATION

(1.1) BECAUSE OF SOIL COMPACTION DURING CONSTRUCTION, ALL PLANTING AREAS SHALL BE ROTOTILLED TO A DEPTH AS SHOWN IN DETAILS OR AS SPECIFIED IN WRITTEN SPECIFICATIONS . A PLANTING AREA IS ANY AREA IN WHICH NEW PLANTING OCCURS. EXCAVATE THE ENTIRE AREA BOUNDED BY WALKS, WALLS, FENCES, ETC, REMOVE SPOIL MATERIAL AS DIRECTED BY OWNER OR THE OWNER'S REPRESENTATIVE

(1.2) EXCAVATED SOIL SHOULD BE USED AS BACKELL MATERIAL IN ORDER TO ELIMINATE OR MINIMIZE THE OCCURRENCE OF HYDROLOGIC DISCONTINUITIES, AND/OR SOIL INTERFACE PROBLEMS COMMON TO PLANTING BEDS CONTAINING SOILS OF DIFFERENT TEXTURE, WHERE THE TEXTURE OF THE EXSTING SOIL IS UNDESIREABLE FOR THE PLANT SPECIES BEING PLANTED (i.e. HEAVY CLAY, PURE SAND) AND WHERE THE pH OF THE EXISTING SOIL IS SUITABLE FOR THE SPECIES BEING PLANTED, THE SOIL SHALL BE BLENDED 66% EXISTING SOIL WITH 33% AMENDED SOIL

(1.3) WHERE IT IS DETERMINED THAT THE EXISTING SOIL EXCAVATED IS TOTALLY UNSUITABLE FOR USE AS BACKFILL MATERIAL BECAUSE OF IMPROPER DH OR THE PRESENCE OF DEBRIS OR OTHER DELETERIOUS MATTER, THE BACKFILL MATERIAL SHALL BE 100% AMENDED SOIL MIXTURE AS DESCRIBED BELOW WITH THE ADDITION OF 1/2 PART SAND AMENDED SOIL: PLANTING SOIL FOR AMENDING BACKFILL SHALL BE 100 % TOPSOIL WITH AMENDMENTS ADDED ACCORDING TO THE RECOMMENDATIONS OF THE SOILS TEST REPORT TO BRING THE pH VALUE OF THE PLANTING BACKFILL MIXTURE WITHIN THE RANGES DESCRIBED BELOW. THE TOPSOIL AND AMENDMENTS SHALL BE MIXED AT AN ON-SITE LOCATION, PLANTING SOIL SHALL NOT BE MIXED AT INDIVIDUAL PLANT LOCATIONS.

(2) TOPSOIL AND ALL SOIL AMENDMENTS

(2.1) NECESSARY QUANTITIES OF TOPSOIL SHALL BE SUPPLIED BY THE CONTRACTOR AND APPROVED BY THE OWNER OR HIS REPRESENTATIVE. THE CONTRACTOR SHALL APPLY TOPSOIL ONLY AFTER SECURING SOIL TEST (V.P.I.), APPLYING RECOMMENDED TREATMENT THEREOF, AND SUBMITTING FOR APPROVAL

(2.2) ON-SITE TOPSOIL MEETING THE CONDITIONS FOR THESE NOTES MAY BE USED OR IF INSUFFICIENT QUANTITIES ARE AVAILABLE OUTSIDE TOPSOIL MEETING THE FOLLOWING CRITERIA SHALL BE

(2.3) ON-SITE TOPSOIL SHALL BE STOCKPILED TOPSOIL THAT HAS BEEN SALVAGED IN ACCORDANCE WITH SECTION 303.04(A) OF THE V.D.O.T. SPECIFICATIONS. IT SHALL BE FREE FROM REFUSE. OR ANY MATERIAL TOXIC TO PLANT GROWTH, AND REASONABLY FREE FROM SUBSOIL STUMPS, ROOTS, BRUSH, STONES, CLAY, LUMPS, OR SIMILAR OBJECTS LARGER THAN 3" IN THEIR GREATEST DIMENSION.

(2.4) OFF-SITE TOPSOIL, IF NEEDED, SHALL BE TOPSOIL FURNISHED FROM SOURCES OUTSIDE THE PROJECT LIMITS AND SHALL BE THE ORIGINAL TOP LAYER OF A SOIL PROFILE FORMED UNDER NATURAL CONDITIONS, TECHNICALLY DEFINED AS THE "A" HORIZON BY THE SOIL SOCIETY OF AMERICA, IT SHALL CONSIST OF NATURAL, FRIABLE, LOAMY SOIL WITHOUT ADMIXTURES OF SUBSOIL. OR OTHER FOREIGN MATERIALS, AND SHALL BE REASONABLY FREE FROM STUMPS, ROOTS, HARD LUMPS, STIFF, CLAY, STONE, NOXIOUS WEEDS, BRUSH, OR OTHER LITTER. IT SHALL HAVE DEMONSTRATED BY EVIDENCE OF HEALTHY VEGETATION GROWING, OR HAVING GROWN ON IT, PRIOR TO STRIPPING. THAT IT IS REASONABLY WELL DRAINED AND DOES NOT CONTAIN SUBSTANCES TOXIC TO PLANTS

(2.4.1) "A" HORIZON: "A" HORIZONS SHALL BE MINERAL HORIZONS CONSISTING OF (1) HORIZONS OR ORGANIC MATTER ACCUMULATION FORMED OR FORMING AT OR ADJACENT TO THE SURFACE: (2) HORIZONS THAT HAVE LOST CLAY, IRON, OR ALUMINUM, WITH RESULTANT CONCENTRATIONS OF QUARTZ OR OTHER RESISTANT MINERALS, OF SAND OR SILT SIZE: OR (3) HORIZONS DOMINATED BY 1 OR 2 ABOVE BUT TRANSITIONAL TO AN UNDERLYING B OR C. (2.4.2) "A" HORIZON SUBDIVISIONS: A1 HORIZONS SHALL BE MINERAL HORIZONS, FORMED OR FORMING AT OR ADJACENT TO THE SURFACE, IN WHICH THE FEATURE EMPHASIZED IS AN ACCUMULATION OF

ORGANIC MATERIAL IS ASSUMED TO BE DERIVED FROM PLANT AND ANIMAL REMAINS DEPOSITED ON THE SURFACE OF THE SOIL OR DEPOSITED WITHIN THE HORIZON WITHOUT APPRECIABLE TRANSLOCATION.

A2 HORIZONS SHALL BE MINERAL HORIZONS IN WHICH THE FEATURE EMPHASIZED IS LOSS OF CLAY, IRON OR ALUMINUM, WITH RESULTANT CONCENTRATION OF QUARTZ OR OTHER RESISTANT MINERALS IN SAND AND SILT SIZES

(2.4.3) "A" HORIZON TOPSOIL CONTENT: "A" HORIZON TOPSOIL SHALL BE N ACCORDANCE WITH THE FOLLOWING MATERIALS BY PERCENTAGE OF VOLUME: SILT 42-58%

CLAY 15-20%

ORGANIC MATERIAL 12-18%

(2.5) TOPSOIL SHALL HAVE A pH IN THE RANGE OF 6.0 TO 7.0 PRIOR TO MIXING WITH AMENDMENTS. IF THE pH IS NOT WITHIN THIS RANGE. THE pH SHALL BE CORRECTED AT THE CONTRACTOR'S EXPENSE OR A DIFFERENT SOURCE OF SUPPLY SHALL BE SELECTED. TOPSOIL SHALL BE SUBJECT TO INSPECTION BY THE OWNER OR THE OWNER'S REPRESENTATIVE AT THE SOURCE OF SUPPLY AND IMMEDIATELY PRIOR TO USE IN THE PLANTING OPERATIONS.

(2.6) PLANTING SOIL AFTER AMENDING FOR DECIDUOUS PLANTS SHALL HAVE A pH VALUE BETWEEN 6.0 AND 7.0, AND FOR EVERGREEN OR SEMI-EVERGREEN PLANTS SHALL HAVE A pH VALUE BETWEEN 5.0 AND 6.0. A REPRESENTATIVE SAMPLE FROM THE EXCAVATED SOIL SHALL BE FIELD TESTED FOR pH UTILIZING A RELIABLE SOIL pH METER OR SOIL pH TEST KIT THE DH VALUE OF THE NATURAL SOIL BACKFILL MIXTURE MAY BE AMENDED BY ADDING LIMESTONE OR ALUMINUM SULFATE AS

(3) EXCAVATION OF PLANT PITS

(3.1) PRIOR TO EXCAVATION OF TREE PITS. AN AREA EQUAL TO TWO TIMES THE DIAMETER OF THE ROOT BALL SHALL BE ROTO-TILLED TO A DEPTH EQUAL TO THE DEPTH OF THE ROOT BALL. (3.2) IN CONTINUOUS SHRUB AND GROUND COVER BEDS, THE ROTO-TILLED PERIMETER SHOULD EXTEND TO A DISTANCE OF ONE FOOT BEYOND THE DIAMETER OF A SINGLE ROOTBALL. THE BED SHALL BE TILLED TO A DEPTH EQUAL TO THE ROOT BALL DEPTH PLUS 6". (3.3) TREE PITS FOR WELL DRAINED SOILS SHALL BE DUG SO THAT THE BOTTOM OF THE ROOT BALL WILL REST ON UNDISTURBED SOIL AND THE TOP OF THE ROOT BALL WILL BE FLUSH WITH FINISH GRADE. IN POORLY DRAINED SOILS THE TREE PIT SHALL BE DUG SO THAT THE ROOT BALL RESTS ON UNDISTURBED SOIL AND THE TOP OF THE ROOT BALL IS 11

ABOVE FINISH GRADE. PLANT PIT WALLS SHALL BE SCARIFIED PRIOR TO

PLANT INSTALLATION. (3.4)SHRUB BEDS SHALL BE EXCAVATED TO 6" BELOW THE ROOT BALL

OF THE SHRUB (3.5) ALL AIR POCKETS SHALL BE REMOVED FROM PLANT PIT UPON BACK FILLING WITH PLANTING SOIL BY FILLING APPROXIMATELY 1/2 TO 2/3 OF THE PIT WITH PLANTING BACKFILL MATERIAL, TAMPING BACKFILL MATERIAL AND THEN WATERING TO ENSURE SETTLEMENT OF THE MATERIAL BACKFILL MATERIAL SHALL THEN BE PLACED WITHIN THE REMAINING CAVITIES OF THE PLANT PIT, TAMPING AND WATERED AGAIN TO ENSURE SETTLEMENT OF THE BACKFILL MATERIAL, UNDER NO. CIRCUMSTANCES SHALL ANY SOIL OR BACKFILL MATERIAL BE APPLIED

ABOVE THE ROOT BALL OF THE PLANTS.
(3.6) GROUND COVERS SHALL BE PLANTED IN BEDS HAVING A MINIMUM DEPTH OF 4" BELOW THE PROPOSED ROOT DEPTH. PLANTS SHALL BE EVENLY SPACED AND SET TO MAINTAIN THE ORIGINAL GROWING DEPTH WHILE ALLOWING FOR A 2" TOP DRESSING OF MULCH.

(4) PLANT MATERIAL AND MULCH (4.1) THE NAMES OF PLANTS REQUIRED UNDER THIS CONTRACT CONFORM TO THOSE GIVEN IN L.H. BAILEY'S HORTUS THIRD, 1976 EDITION NAMES OF VARIETIES NOT INCLUDED THEREIN CONFORM. GENERALLY WITH NAMES ACCEPTED IN THE NURSERY TRADE. ALL PLANTS SHALL HAVE A HABIT OF GROWTH THAT IS NORMAL FOR THEIR SPECIES AND THEY SHALL BE SOUND. HEALTHY AND VIGOROUS, WITH WELL DEVELOPED ROOT SYSTEMS. ALL PLANT MATERIAL SHALL BE FREE FROM INSECT PESTS, PLANT, DISEASES, AND INJURIES, ALL PLANTS SHALL EQUAL OR EXCEED THE MEASUREMENTS SPECIFIED IN THE PLANT LIST, WHICH ARE MINIMUM ACCEPTABLE SIZES. TREES SHALL HAVE SINGLE TRUNKS EXCEPT AS NOTED, ALL SHRUBS SHALL BE HEALTHY, VIGOROUS, AND OF GOOD COLOR. ONLY DAMAGED OR BROKEN BRANCHES OF PLANT MATERIAL MAY BE PRUNED AND ANY NECESSARY PRUNING SHALL BE DONE AT THE TIME OF PLANTING. HOWEVER, UNDER NO CIRCUMSTANCES SHALL THE CENTRAL LEADER OF A PLANT BE PRUNED

(4.2) ALL TAGS, STRINGS OR ANY OTHER MATERIAL ATTACHED TO THE PLANTS SHALL BE REMOVED AT THE TIME OF THE PLANTING, BALLING AND BURLAPPING OF PLANTS SHALL FOLLOW THE CODE OF STANDARDS CURRENTLY RECOMMENDED BY THE AMERICAN STANDARD FOR NURSERY STOCK.

(4.3) SUBSTITUTIONS WILL BE PERMITTED ONLY UPON SUBMISSION OF PROOF THAT ANY PLANT IS NOT OBTAINABLE, ALL SUBSTITUTIONS MUST BE AUTHORIZED BY THE OWNER OR THE OWNER'S REPRESENTATIVE IN WRITING PROVIDING FOR USE OF THE NEAREST EQUIVALENT OBTAINABLE SIZE OR VARIETY OF PLANT HAVING THE SAME ESSENTIAL CHARACTERISTICS AS THE ORIGINAL VARIETY WITH AN EQUITABLE ADJUSTMENT OF CONTRACT PRICE

(4.4) BALLED AND BURLAPPED PLANTS (B&B) SHALL BE DUG WITH FIRM, NATURAL BALLS OF EARTH OF SUFFICIENT DIAMETER AND DEPTH TO ENCOMPASS THE FIBROUS AND FEEDING ROOT SYSTEM NECESSARY FOR FULL RECOVERY OF THE PLANT. BALLS SHALL BE FIRMLY WRAPPED WITH BURLAP OR SIMILAR MATERIAL AND BOUND WITH TWINE OR CORD. BURLAP SHALL NOT BE PULLED OUT FROM UNDER BALLS DURING PLANTING OPERATIONS B&B PLANTS WHICH CANNOT BE PLANTED IMMEDIATELY ON DELIVERY SHALL BE COVERED WITH MOIST SOIL, MULCH, OR OTHER MATERIAL TO PROVIDE PROTECTION FROM DRYING WINDS AND SUN.

CONTAINER GROWN WITH WELL ESTABLISHED ROOT SYSTEMS, LOOSI CONTAINERIZED PLANT MATERIAL WILL NOT BE ACCEPTED. ALL PLANTS INJURED AND PLANTS WITH ROOT BALLS BROKEN DURING TRANSPORT OR PLANTING OPERATIONS WILL BE REJECTED. BARE-ROOTED PLANTS (BR) SHALL BE PLANTED OR HEELED-IN IMMEDIATELY LIPON DELIVERY ALL PLANTS SHALL BE WATERED AS NECESSARY UNTIL PLANTED.

(4.6) NEW PLANTINGS SHALL BE LOCATED WHERE SHOWN ON THE PLAN EXCEPT WHERE OBSTRUCTIONS BELOW GROUND ARE ENCOUNTERED OR WHERE CHANGES HAVE BEEN MADE IN THE PROPOSED CONSTRUCTION. NECESSARY ADJUSTMENTS SHALL BE MADE ONLY AFTER APPROVAL BY THE OWNER OR THE OWNER'S REPRESENTATIVE. REASONABLE CARE, SHALL BE EXERCISED TO HAVE PLANTING PITS DUG AND SOIL PREPARED PRIOR TO MOVING PLANTS TO THEIR RESPECTIVE LOCATIONS TO ENSURE THAT THEY WILL NOT BE UNNECESSARILY

EXPOSED TO DRYING OR PHYSICAL DAMAGE.
(4.7) A LIST OF PLANTS, INCLUDING SIZES, QUANTITIES AND OTHER REQUIREMENTS, IS SHOWN ON THE DRAWINGS. THE CONTRACTOR IS RESPONSIBLE FOR VERIFYING THE QUANTITIES AS SHOWN ON THE DRAWINGS, IF DISCREPANCIES OCCUR IN THE QUANTITIES SHOWN, THE

PLANTING PLANS SHALL GOVERN. (4.10) AT THE TIME OF PLANTING, AND AS MANY TIMES LATER AS SEASONAL CONDITIONS REQUIRE, EACH PLANT AND THE SOIL AROUND IT SHALL BE THOROUGHLY WATERED, CARE SHOULD BE EXERCISED WHEN WATERING TO AVOID FLOODING OF PLANTS AND BEDS, DISPLACEMENT OF MULCH MATERIAL AND EROSION OF SOIL. AVOID USE OF HIGH PRESSURE HOSES. THE CONTRACTOR SHALL MAKE, AT HIS EXPENSE, WHATEVER ARRANGEMENTS MAY BE NECESSARY TO ENSURE AN ADEQUATE SUPPLY OF WATER TO MEET THE NEEDS OF THIS CONTRACT DURING INSTALLATION. THE CONTRACTOR SHALL ALSO FURNISH ALL NECESSARY HOSE. EQUIPMENT ATTACHMENTS AND ACCESSORIES FOR THE ADEQUATE WATERING OF PLANTED AREAS AS MAY BE REQUIRED UNTIL ACCEPTANCE BY THE OWNER OR THE OWNER'S REPRESENTATIVE.

(4.11) MULCH SHALL BE CLEAN, GROUND OR SHREDDED BARK OR HARDWOOD MULCH. IN PLANTING AREAS WHERE SLOPES EXCEED 3:1 AND AT DRAINAGE DISPERSION POINTS OR ALONG NATURAL WATER WAYS WHERE CONCENTRATIONS OF SURFACE WATER EMPTY FROM CULVERTS OR PAVED DITCHES, HEAVY JUTE MESH SHALL BE INSTALLED. SHREDDED HARDWOOD OR BARK MULCH SHALL HAVE BEEN COMPOSTED FOR AT LEAST TWO MONTHS PRIOR TO APPLICATION. FRESHLY GROUND MULCH WILL NOT BE ACCEPTED. FINELY GROUND MULCH WHICH INHIBITS DRAINAGE. ENCOURAGES WEED GROWTH OR BECOMES WATERLOGGED WILL NOT BE ACCEPTED. MULCH SHALL BE COMPOSED OF SIMILAR SIZED FRAGMENTS AND SHALL NOT CONTAIN STICKS, CONES, LEAVES, UNSHREDDED, PIECES OR OTHER DELETERIOUS MATTER. ALL AZALEA AND CAMELLIA PLANTING BEDS SHALL HAVE 1" OF PINE STRAW MULCH UNDER 2" OF BARK OR SHREDDED HARDWOOD MULCH.

(4.12) ALL PLANTS SHALL BE MULCHED IMMEDIATELY AFTER PLANTING GROUND COVERS SHALL BE MULCHED WITH A 2" LAYER OF SHREDDED HARDWOOD OR BARK MULCH. ALL OTHER PLANTING BEDS, SHRUBS AND TREE PLANTINGS SHALL BE MULCHED WITH A 3" MINIMUM LAYER OF MULCH THIS MULCH SHALL ENTIRELY COVER THE AREA, OF THE PLANTING PIT, BED. OR EARTH BERM AROUND EACH PLANT WITH THE EXCEPTION OF THE AREA IMMEDIATELY ADJACENT TO THE PLANT TRUNK OR TRUNKS. THE AREA IMMEDIATELY ADJACENT TO THE PLANT TRUNK OR TRUNKS SHALL BE LEFT FREE OF ANY MULCH.

(5.1) THE FERTILIZER SHOULD BE A DRY SLOW RELEASE FORM OF FERTILIZER. IT SHOULD CONTAIN AT LEAST 25-50% WATER INSOLUBLE NITROGEN THE FERTILIZER SELECTED SHOULD ALSO HAVE A LOW ADJUSTED SALT INDEX TO PREVENT BURNING. THE N-P-K RATIO SHOULD NOT EXCEED 3-1-2 UNLESS THE SOIL TEST REVEALS THAT ADDITIONAL LEVELS OF P AND K ARE NECESSARY.

(5.2) FOR DECIDUOUS TREES, USE OSMOCOTE (18-6-12) AT THE RATE EQUIVALENT TO 4 LBS ACTUAL N/1000 SQ FT OF ROOT ZONE AREA/YEAR. FOR EVERGREEN TREES USE 2 LBS ACTUAL N/1000 SQ FT OF ROOT ZONE

(5.3) MIX THE FERTILIZER INTO THE BACKFILL SOIL OF THE TREE PITS. FOR SHRUB BEDS. MIX THE FERTILIZER INTO THE AREA THAT HAS BEEN ROTO-TILLED FOR THE PLANTS.

(5.4) THE FERTILIZER RATE FOR CONTINUOUS GROUND COVER AND SHRUB BEDS SHOULD BE DERIVED BY CALCULATING THE ENTIRE ROOT ZONE AREA. THE ROOT ZONE AREA IS FOUND BY MEASURING THE AREA CONTAINING THE MULTIPLE PLANT ROOTS, USE, OSMOCOTE (18-6-12) AT A RATE EQUIVALENT TO 2 LBS OF N /1000 SQ FT OF ROOT ZONE AREA. THE FERTILIZER SHOULD BE EVENLY DISTRIBUTED WITHIN THE SHRUB BED. SOIL (5.5) ALWAYS BE SURE THAT ADEQUATE MOISTURE IS AVAILABLE WHEN FERTILIZING SO THAT THE FERTILIZER WILL BE DISSOLVED INTO THE SOIL SOLUTION FOR ROOT LIPTAKE AND TO AVOID BURNING THE ROOTS.

(6) STAKING

(6.1) ALL TREES SHALL BE STAKED ACCORDING TO THE TYPICAL DETAILS

(6.2) THREE STAKES SHALL BE REQUIRED PER TREE. THE STAKES SHALL BE DRIVEN IN A RADIAL PATTERN, VERTICALLY INTO THE GROUND OUTSIDE THE EDGE OF THE ROOTBALL TO A DEPTH OF 2 1/2 ' TO 3', ON OPPOSITE SIDES OF THE TREE IN SUCH A MANNER AS NOT TO INJURE THE ROOT BALL OR ROOTS. STAKES FOR SUPPORTING TREES SHALL BE 1.5" X 1.5" SQUARE OR ROUND, BY 8', THE STAKES, SHALL BE SOUND WOOD TREATED WITH A SUITABLE WOOD PRESERVATIVE. WIRE OR CABLE SIZES SHALL BE AS FOLLOWS: TREES UP TO 65 MM (2.5 IN.) CALIPER - 14 GALIGE TREES 65 MM (2.5 IN.) TO 75 MM (3 IN.) CALIPER - 12 GAUGE TIGHTEN WIRE OR CABLE ONLY ENOUGH TO KEEP FROM SLIPPING. ALLOW FOR SOME TRUNK MOVEMENT, PLASTIC HOSE SHALL BE LONG ENOUGH TO ACCOMMODATE 35MM (1.5 IN.) OF GROWTH AND BUFFER ALL

BRANCHES FROM THE WIRE TUCK ANY LOOSE ENDS OF THE WIRE OR

MINIMUM OF 12 MM (0.5 IN)

(6.3) WOODEN STAKES AND WIRE TIES SHOULD BE REMOVED AFTER ONE

YEAR. (7) CHEMICAL APPLICATION

(7.1) ALL PESTICIDES SHALL BE PRODUCTS OF RECOGNIZED COMMERCIAL MANUFACTURERS, AND SHALL CONFORM TO ALL APPLICABLE FEDERAL. STATE, AND LOCAL PESTICIDE LAWS. PESTICIDES SHALL BE APPLIED WITH CALIBRATED FOLIPMENT, ACCORDING TO FPA LABEL RESTRICTIONS AND REGULATIONS BY A CERTIFIED APPLICATOR. ANY DAMAGE INCURRED TO THE SITE, ADJACENT PROPERTIES, OR APPLICATOR DURING PESTICIDE APPLICATIONS WILL BE THE SOLE RESPONSIBILITY OF THE CONTRACTOR (7.2) PESTICIDES SHOULD BE USED ONLY WHEN NECESSARY TO TREAT AN OUTBREAK OF A HARMFUL PEST OR DISEASE PROBLEM. THE OWNER OR THE OWNER'S REPRESENTATIVE SHALL BE NOTIFIED 24 HOURS PRIOR TO THE APPLICATION OF ANY PESTICIDE (8) MAINTENANCE AND GUARANTEE

(8.1) THE LANDSCAPE CONTRACTOR SHALL BE RESPONSIBLE FOR MAINTAINING HIS WORK FOR THE PERIOD OF ONE YEAR AFTER ACCEPTANCE BY THE OWNER OR THE OWNER'S REPRESENTATIVE MAINTENANCE SHALL INCLUDE WATERING, WEEDING, CULTIVATING, MULCHING, REMOVAL OF DEAD MATERIALS, RESETTING OF PLANTS TO PROPER GRADES OR UPRIGHT POSITIONS. RESTORATION OF EARTH BERMS. AND OTHER NECESSARY OPERATIONS. ADEQUATE PROTECTION FOR LAWN AREAS AGAINST TRESPASSING DURING PLANTING OPERATIONS AND AGAINST DAMAGE OF ANY KIND SHALL BE PROVIDED. NOTHING IN THESE NOTES IS INTENDED TO RELIEVE THE CONTRACTOR OF HIS RESPONSIBILITY TO REPAIR EXISTING LAWN AREAS DAMAGED BY WORKMEN ENGAGED IN THE COMPLETION OF THIS PROJECT.

(8.2) INSPECTION OF THE WORK TO DETERMINE COMPLETION OF THE CONTRACT EXCLUSIVE OF THE POSSIBLE REPLACEMENT OF PLANTINGS, WILL BE MADE BY THE OWNER OR THE OWNER'S REPRESENTATIVE AT THE CONCLUSION OF THE INSTALLATION PERIOD UPON WRITTEN NOTICE REQUESTING SUCH INSPECTION. REQUEST SHALL BE SUBMITTED BY CONTRACTOR AT LEAST TEN DAYS PRIOR TO THE ANTICIPATED DATE FOR INSPECTION. AFTER INSPECTION, THE CONTRACTOR WILL BE NOTIFIED IN WRITING BY THE OWNER OR THE OWNER'S REPRESENTATIVE OF ACCEPTANCE OF THE WORK, EXCLUSIVE OF THE POSSIBLE REPLACEMENT OF PLANTS SUBJECT TO GUARANTEE; OR, IF THERE ARE ANY DEFICIENCIES, THE CONTRACTOR WILL BE NOTIFIED OF THE REQUIREMENTS NECESSARY FOR COMPLETION OF THE WORK. PLANTINGS SHALL NOT BE CONSIDERED ACCEPTED UNTIL ALL DEFICIENCIES HAVE BEEN CORRECTED AND APPROVED IN WRITING.


(8.3) NURSERY STOCK SHALL BE FULLY GUARANTEED FOR ONE FULL YEAR ALL PLANTS THAT FAIL TO MAKE NEW GROWTH FROM A DORMANT CONDITION OR THAT DIE DURING THE FIRST YEAR AFTER PLANTING SHALL BE REPLACED. ALL REPLACEMENTS SHALL CONFORM WITH THE ORIGINAL SPECIFICATIONS AS TO SIZE AND TYPE. ALL. COSTS OF REPLACEMENTS SHALL BE BORNE BY THE CONTRACTOR

(9) ALL OTHER ITEMS NECESSARY TO MAKE WORK COMPLETE

(9.1) ANY PLANT MATERIAL NOT PLANTED SHALL BE REMOVED FROM THE SITE. THE CONTRACTOR SHALL BE RESPONSIBLE FOR THE REMOVAL OF ALL UNUSED RUBBISH AND DEBRIS FROM THE SITE UPON COMPLETION OF

CONTRACTOR SHALL ASSURE PERCOLATION OF ALL PLANTING PITS PRIOR TO INSTALLATION. FINAL TREE STAKING DETAILS AND
PLACEMENT TO BE APPROVED BY OWNER.
"TREE SAVER" ANCHORING SYSTEM MAY BE SUBSTITUTED FOR WOOD STAKING

SYSTEM UPON APPROVAL BY OWNER OR OWNER'S REPRESENTATIVE.

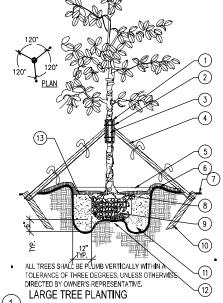

VICINITY SKETCH (NOT TO SCALE)

1. FIVE (5) LAYERS OF BURLAP TO PROTECT TRUNK.

2. TWO STEEL BANDS TO SECURE BATTENS.

3. FIVE 2" X 4" X 18" WOOD BATTENS.

4. NAIL F NECESSARY TO BATTENS 2" X 4" STAKES FLAG AT MIDPOINT AND AT BASE.

5. 3" MINIMUM OF MULCH AS SPECIFED.
WHERE TREES ARE PLACED IN SOD.
MULCH RING FOR LARGE TREES SHALL
EXTEND APPROX 6" BETOND EARTH
SAUCER BERN INLESS INDICATED.

0. THERWISE BY OWNERS REPRESENTATIVE.

5. 50L BERN TO HOLD WATER.
7. FINISHED GRADE (SEE GRADING PLAN).

8. TOP OF ROOTBALL MIN. 1" ABOVE FINISHED GRADE.

9. B&B OR CONTAINERIZED (SEE SPECIFICATIONS FOR ROOT BALL
REQUIREMENTS).


10. 2" x 4" x 3" (MIN), P.T. WOOD STAKES

10. 2" x 4" x 3' (MIN), P.T. WOOD STAKE BURIED 3" BELOW FINISHED GRADE, OF OWNER APPROVED STAKING METHOD.

11. PREPARED PLANTING SOIL AS SPECIFIED. (SEE LANDSCAPE NOTES).

12. ROOTBALLS GREATER THAN 24* DIAMETER SHALL BE PLACED ON MOUND OF UNDISTURBED SOIL TO PREVENT SETTLING.

13. APPROVED WEED BARRIER

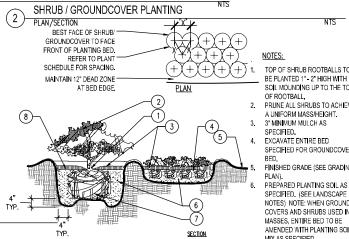

PLANT SCHEDULE FINAL PLANT QUANTITIES AND SPECIES TO BE PROVIDED AT A LATER SUBMISSION.

KEY	QTY.	BOTANICAL / COMMON NAME CANOPY TREES	SIZE	ROOT	COMMENTS	TYP
TG	15	Tilia cordata 'Greenspire' Greenspire Littleleaf Linden	3" cal.	B&B	Strong Central Leader	
		ORNAMENTAL TREES				
LI	3	Lagerstroemia indica 'Natchez' Natchez Crapemyrtle	6-8'	B&B	Multi-Stem, 3 Stem Min.	
		SHRUBS / ORNAMENTAL GRASSES				
RHA	23	Rhaphiolepis indica 'Monto' Indian Princess Indian Hawthorne	24" ht.	Cont.	Upright, rounded form	
PAH	41	Pennisetum alopecuroides 'Hameln' Dwarf Fountain Grass	3 Gal.	Cont.	Upright, rounded form	
BAR	27	Berberis thunbergii 'Gentry' PP#9461 Royal Burgundy Barberry	24" ht.	Cont.	Upright, rounded form	
		PERENNIALS				
HEM	1545	Hemerocallis x 'Rosy Returns' Rosy Returns Daylily	1 Gal.	Cont.	18" o.c. Full, dense	(C)
SED	551	Sedum x 'Autumn Joy'	1 Qt.	Cont.	18" o.c. Full, dense	1700 WILI

ALL SHRUBS AND GROUNDCOVERS SHALL BE PLUMB VERTICALLY, UNLESS OTHERWISE DIRECTED BY OWNER'S

BOTTOM APPROVED WEED BARRIER

60% PLANS - Ø8/14/14

TO BE USED FOR ANY TYPE OF CONSTRUCTION.

Kimley » Horn

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LLOW LAWN DRIVE, SUITE 200, RICHMOND, VA 23230 PHONE: (804) 673-3882 FAX: (804) 673-3980

HUMIDIFIED ORGANIC MATTER INTIMATELY ASSOCIATED WITH THE MINERAL FRACTION. THE SOIL IS A DARK OR DARKER THAN UNDERLYING HORIZONS BECAUSE OF THE PRESENCE OF ORGANIC MATTER. THE CABLE INTO THE WIRE WRAP SO THAT NO SHARP WIRE ENDS ARE EXPOSED. ASSURE THAT THE BEARING SURFACE OF THE PROTECTIVE (4.5) PLANTS NOTED "CONTAINER" ON THE PLANT LIST MUST BE Autumn Joy Stonecrop VERING OF THE WIRE OR CABLE AGAINST THE TREE TRUNK IS Technical Administrative IDLEWOOD AVENUE ROUNDABOUT PROJECT Property owners correct as of _____ RÌCHMOND Project Engin Ordinance Number Deputy Director for Transportation / Public Work LANDSCAPE DETAILS CIP: 040-000-000-0000 City Traffic Engine DEPARTMENT OF PUBLIC WORKS AS NOTED 08-14-14 RICHMOND VIRGINIA

SOIL MOUNDING UP TO THE TO OF ROOTBALL. 2 PRUNE ALL SHRUBS TO ACHIEV

A UNIFORM MASS/HEIGHT

3. 3* MINIMUM MULCH AS SPECIFIED. EXCAVATE ENTIRE BED

SPECIFIED FOR GROUNDCOVE FINISHED GRADE (SEE GRADIN

PLAN).
PREPARED PLANTING SOIL AS SPECIFIED (SEE LANDSCAP NOTES) NOTE: WHEN GROUND COVERS AND SHRUBS USED IN MASSES, ENTIRE BED TO BE AMENDED WITH PLANTING SOI

MIX AS SPECIFIED. SCARIFY ROOTBALL SIDES AND

THESE PLANS ARE UNFINISHED AND UNAPPROVED AND ARE NOT